


125mm THK CONCRETE FLOORING
REINFORCED WITH 10mm Ø DRSB
SPACED @ 0.30m OCBW ON 25mm
COMPACTED GRAVEL BALLAST, w/
2mm POLYETHYLENE MOISTURE
PROTECTION

500mm THK CONCRETE FLOORING
REINFORCED WITH 12mm Ø DRSB
SPACED @ 0.30m OCBW ON 25mm
COMPACTED GRAVEL BALLAST, w/
2mm POLYETHYLENE MOISTURE
PROTECTION

125mm THK CONCRETE FLOORING
REINFORCED WITH 10mm Ø DRSB
SPACED @ 0.30m OCBW ON 25mm
COMPACTED GRAVEL BALLAST, w/
2mm POLYETHYLENE MOISTURE
PROTECTION

125mm THK CONCRETE FLOORING
REINFORCED WITH 10mm Ø DRSB
SPACED @ 0.30m OCBW ON 25mm
COMPACTED GRAVEL BALLAST, w/
2mm POLYETHYLENE MOISTURE
PROTECTION

NOTE:
ALL DIMENSIONS ARE SUBJECT
TO FINAL FIELD VERIFICATION

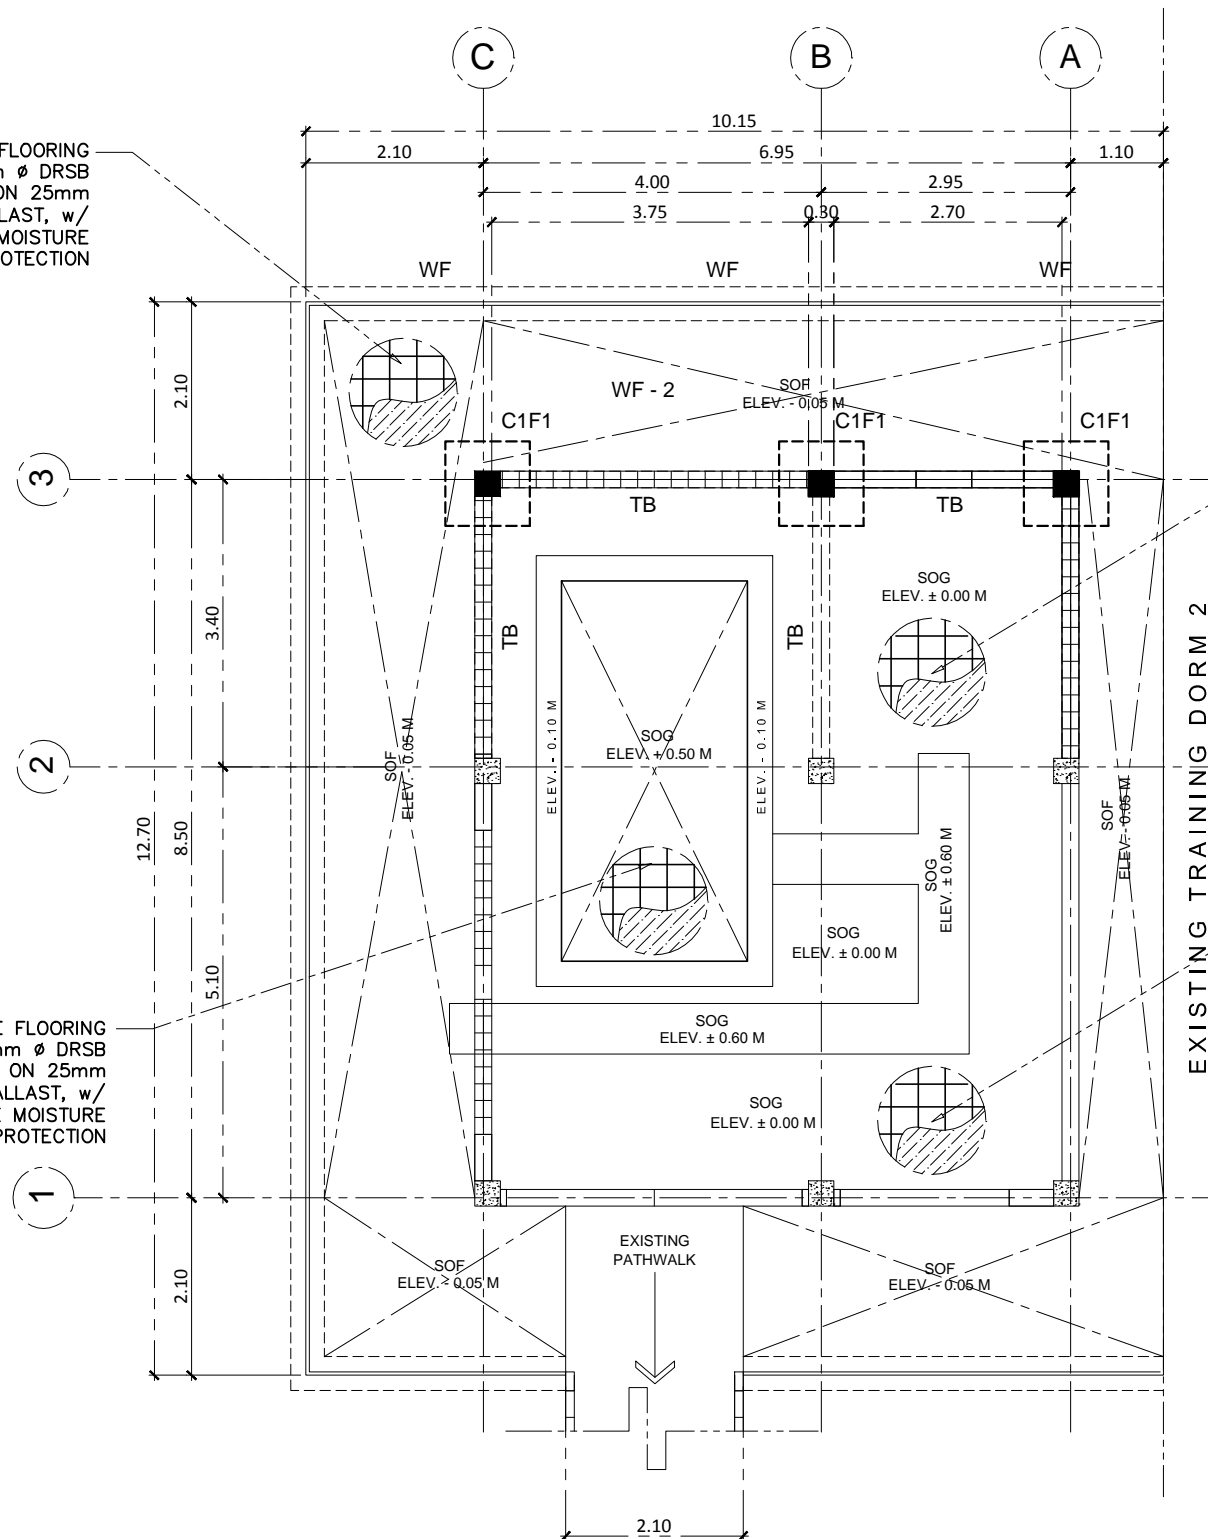

FOUNDATION PLAN
SCALE: 1:75 MTS



R.A. 9266 - Art. 3, Section 20
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PROJECT TITLE:
CROP BIOTECH CENTER POWER HOUSE
LOCATION: PHILRICE-CES, SCIENCE CITY OF MUNOZ, NUEVA ECJA

PRODUCED BY:
PHYSICAL PLANT DIVISION
INFRASTRUCTURE UNIT
PHILRICE
SCIENCE CITY OF MUNOZ, NUEVA ECJA

DESIGNED:

NOTED:
AR. RENATO B. BAJIT
PPD DIVISION HEAD
PHILRICE - CES

END USER:

RECOMMENDING APPROVAL:
ABNER T. MONTECALVO
DED FOR ASF
PHILRICE - CES

APPROVED:
Dr. JOHN C. DE LEON
PHILRICE EXECUTIVE DIRECTOR

DESIGN BY: RBB	SHEET NUMBER	
DATE: NOV2020	S1	
CADD BY: MG		
CHECKED BY:		
DATE:	6	10